

DEPARTMENT OF
ARCHITECTURE
PUNJAB

SR.NO.	NOTES
1.	1. This drawing is submitted for the purpose of the design of the building.
2.	2. The building is to be constructed in accordance with the provisions of the Punjab Building Code, 1974.
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9.	9. The building is to be constructed in accordance with the provisions of the Punjab Building Code, 1974.
10.	10. The building is to be constructed in accordance with the provisions of the Punjab Building Code, 1974.

The drawings are approved by Honorable Cabinet Minister, Research and Medical Education, P.b. vide letter no.7055 dated 18.05.17 received in this office vide letter no: 18093 dated 08.08.17

THIS BUILDING SHOULD BE STRUCTURALLY DESIGNED FOR FOUR STOREYS .

3	DESIGN AMENDED AS SUGGESTED BY PRINCIPAL SEC., MEDICAL EDUCATION GOVT. OF PUNJAB AND DR. K.L. CHAKRABORTI (CONSULTANT/ADVISOR) IN A MEETING DATED 09.05.2018 AT CHANDIGARH.	18.5.18
2	AS DISCUSSED WITH DR. RAJIV DEVGAN, SDE PHSC, S. GURBACHAN SINGH & THE MEMBERS OF THE COMMITTEE, GMC, AMT. ON 22.03.17 GROUND AND FIRST FLOOR OF NUCLEAR MEDICINE BLOCK WILL ONLY BE CONSTRUCTED IN PHASE 1.	22.3.17
1	DRAWING AMENDED	

SR.NO.	REVISIONS	SIGN.	DATE
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(SAPNA)
CHIEF ARCHITECT Ph.

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ADDL.CHIEF ARCHITECT(Pb.)

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NABHA ROAD, PATIALA(Pb.)

DEALT BY: Tejinder Kaur

CHKD BY:

PROPOSED DEPARTMENT OF
NUCLEAR MEDICINE IN
STATE CANCER INSTITUTE (SCI)
AT GOVT. MEDICAL COLLEGE /
GND HOSPITAL AMRITSAR(PB.)

GROUND FLOOR PLAN
GAMMA CAMERA / P.E.T. SCAN

SCALE : 1:200

DATE : 03.06.2016


JOB NO. DRG NO.

M.C.A. 851 R3

REFER:-

BRICK WALL

R.C.C WALL

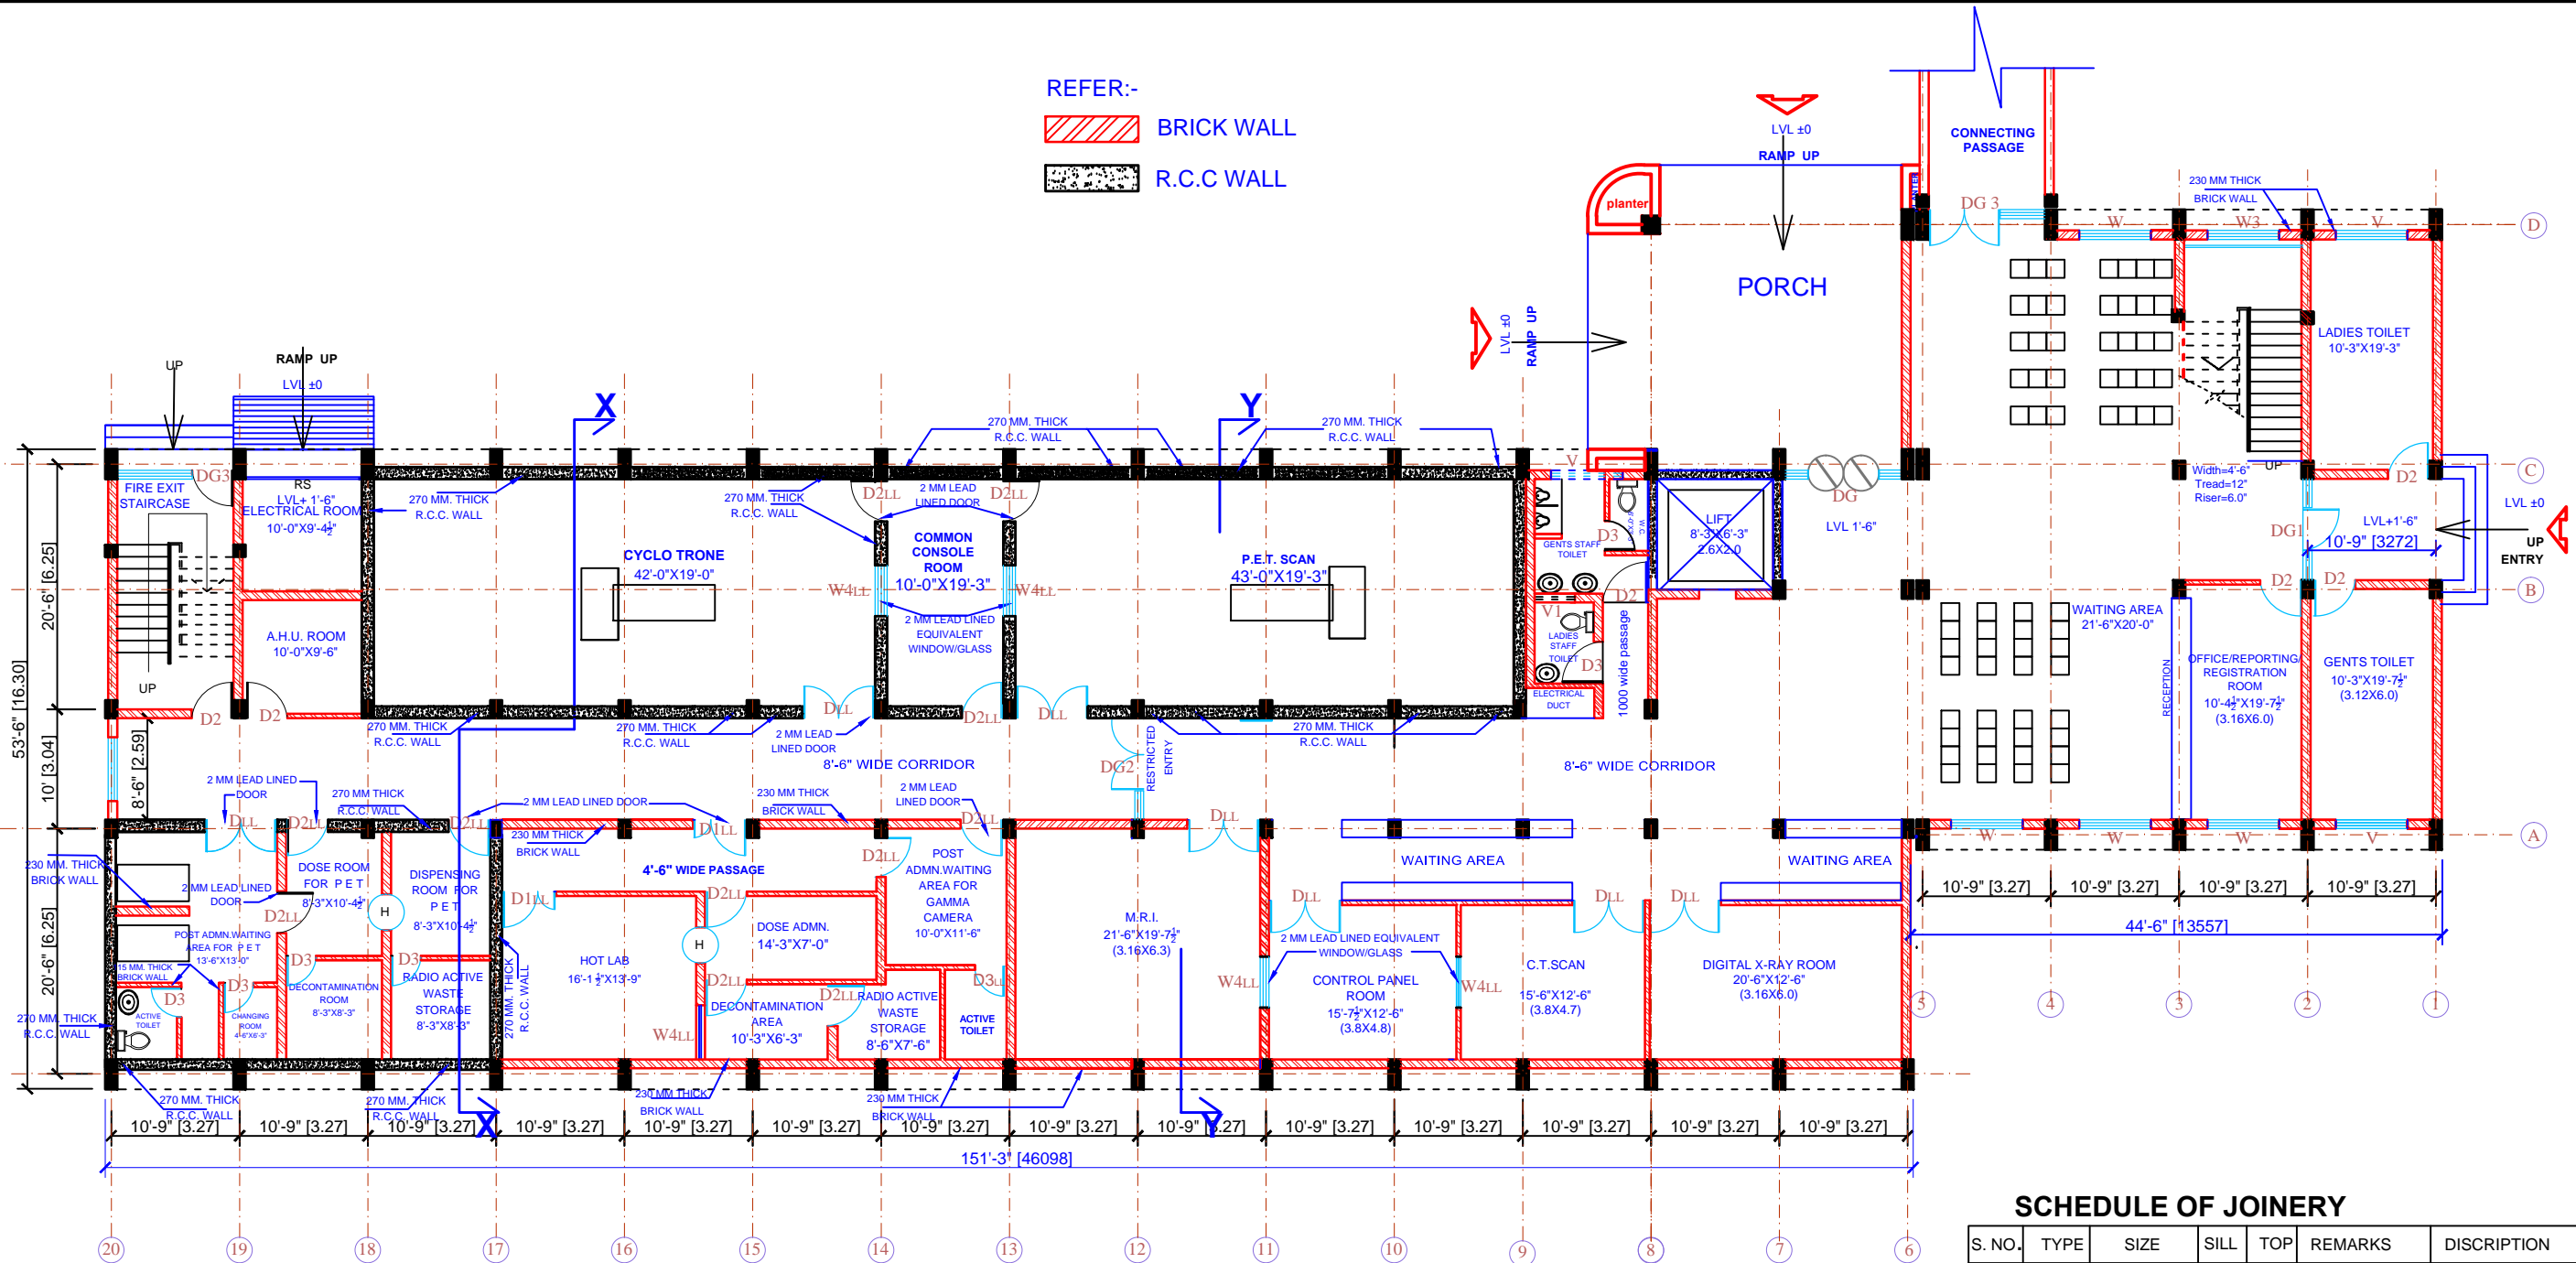

GROUND FLOOR PLAN
GAMMA CAMERA / P.E.T. SCAN

SCHEDULE OF JOINERY

S. NO.	TYPE	SIZE	SILL	TOP	REMARKS	DISCRIPTION
1.	DG	9'-9"X8'-6"	9"	8'-6"	6'-0"X6'-9" main door	
2.	DG1	8'-6"X8'-6"	9"	8'-6"	3'-6"X6'-9"	
3.	DG2	8'-6"X8'-6"	9"	8'-6"	6'-0"X6'-9" door	
4.	DG3	9'-9"X8'-6"	2'- 9"	8'-6"	3'-6"X6'-9"	
5.	DG4	6'-0"X8'-6"	2'- 9"	8'-6"	3'-6"X6'-9"(first floor)	
6.	D	6'-0"X6'-9"	-	6'-9"		
7.	D1	4'-6"X6'-9"	-	6'-9"		
8.	D2	3'-6"X6'-9"	-	6'-9"		
9.	D3	2'-6"X6'-9"	-	6'-9"	TOILET	
10.	DLL	6'-0"X6'-9"	-	6'-9"		2 MM TH. LEAD LINED(LL) DOOR
11.	D1LL	4'-6"X6'-9"	-	6'-9"		2 MM TH. LEAD LINED DOOR
12.	D2LL	3'-6"X6'-9"	-	6'-9"		2 MM TH. LEAD LINED DOOR
13.	W	6'-0"X5'-9"	2'-9"	8'-6"	MAIN WINDOW	
14.	W1	3'-3"X5'-9"	2'-9"	8'-6"	DOCTOR ROOM	
15.	W2	2'-0"X4'-0"	4'-6"	8'-6"	STAIR (FIXED GLASS)	
16.	W3	6'-0"X5'-9"	2'-9"	8'-6"		
17.	W4LL	4'-3"X3'-3"	3'-6"	6'-9"		2 MM TH. LEAD LINED DOOR
18.	V	6'-0"X1'-6"	6'-9"	8'-6"	TOILET	
19.	V1	3'-4 1/2"X1'-6"	6'-9"	8'-6"	TOILET	LADIES STAFF TOILET

NOTES:

- Console: All doors and windows will be of 2mm lead equivalent
 - Dose admin room for P.E.T
 - Post administrative waiting area for P.E.T
 - P.E.T Scan room
 - Gamma camera room
 - Passage leading to Hot lab/Radiopharmacy.
- Restricted entry should remain permanently closed and shall be used only in emergency.
- All the active sinks shall be in stainless steel and have foot /elbow operated fixtures.
- The walls shall be painted with hard washable paint.
- The flooring of hot lab area and high dose therapy ward shall be in Linoleum.
- The walls of P.E.T Scan room & post administrative waiting area for P.E.T shall be in 270 mm thk. R.C.C with 230 mm thk. R.C.C roof slab.
- The Hot Lab. Dose administration room, post administrative waiting area and patient hold and uptake room shall have 230 mm thk. Brick wall and 230 mm thk. R.C.C roof slab.

FINISHES SCHEDULE

AREA	WALL THICKNESS /TYPE	FLOOR FINISH	WALL FINISH
P.E.T	270 MM THK.R.C.C. WALL	EPOXY WITH ANTI STATIC FLOORING	VITRIFIED TILES UPTO CEILING
GAMMA CAMERA	230 MM THK.BRICKWALL	EPOXY WITH ANTI STATIC FLOORING	VITRIFIED TILES UPTO CEILING
HOT LAB	230 MM THK.BRICKWALL	2.5 MM THK. PVC FLOORING	VITRIFIED TILES UPTO CEILING
RADIO PHARMACY	230 MM THK.BRICKWALL	2.5 MM THK. PVC FLOORING	VITRIFIED TILES UPTO CEILING
DOSE ADMN. ROOM	230 MM THK.BRICKWALL	2.5 MM THK. PVC FLOORING	VITRIFIED TILES UPTO CEILING
POST DOSE ADMN ROOM	230 MM THK.BRICKWALL	2.5 MM THK. PVC FLOORING	VITRIFIED TILES UPTO CEILING
CORRIDOR/ WAITING AREA	230 MM THK.BRICKWALL	VITRIFIED TILES	VITRIFIED TILES UPTO CEILING
THERAPY WARDS	230 MM THK.BRICKWALL	VITRIFIED TILES	PLASTIC EMULSION PAINT